

#### Case 1981

**Applicant:** J.W. McCurdy

Owner: Same

**Request:** Site Plan Approval for Riley Cove

**Location:** Anchorage Road, Oxford, MS PPIN# 6707 & 6708

**Zoning:** (RC) Multi-Unit Residential

**Zoning History:** Zoning established in 2004

Surrounding: North: (RC) Multi Unit Residential

South: (RC) Multi Unit Residential

East: (A) Agriculture

West: (RC) Multi Unit Residential

**Planner's Comments**: The subject property is an irregularly shaped lot located on the east side of Anchorage Road, measuring approximately +/- 31,948 square feet. The applicant is seeking to construct Riley Cove, which consists of 9 units with a total of 10 bedrooms. The applicant is proposing one point of ingress and egress at Anchorage Road. Additionally, the applicant has provided more parking for this site than what is required by the current parking requirements.

The stormwater management plan for the subject property is still under review by the Public Works Department. Additionally, the applicant will provide the City with an easement for the water line that will require Board of Alderman approval.

**Recommendation**: Approve the site plan for Riley Cove with the following conditions:

- 1. Approval is contingent on an approved stormwater plan. No permits to be issued prior to approval of that plan.
- 2. Approval is for the site plan as submitted.




Date:			4tn	
Physical Address of Site Tax Parcel # PPIN # Name of Applicant Applicant's Address Phone # Email Address Name of Property Owner Name of Property Owner Name of Professional Submitting Engineer for Project Phone # Ph	Date:	1 <sup>st</sup> Submission	2 <sup>nd</sup> Submission	Submittal Fee: \$250.00
Tax Parcel #	Project Name			
Name of Applicant Applicant's Address Phone # Email Address  Name of Property Owner Name of Professional Submitting Engineer for Project Phone # Phone #  Architect for Project Phone # Phone #  DOCUMENTS REQUIRED FOR SUBMITTAL:  One full scale (24inx36in) set of complete civil drawings, building elevations and landscaping plan. Upload all construction drawings, stormwater report, traffic impact study (if applicable), and other require materials listed below to the City of Oxford's File Drong location  Construction drawing sets must include, but not limited to, the following:  Aerial view of the site clearly indicating the relationship to the surrounding area Indicate location of property of labeling of physical address, zoning of adjoining properties and public or privastreets, adjacent property owners  Site plan to scale, showing property boundaries Site elevations – To Scale AutoCAD 2010 drawing in State of Mississippi East Zone Foot Plane Coordinates Building elevations – including height Grading Plan (Erosion Control Measures) and topo Setbasck locations with the exact location of all buildings and structures Floodplain Zone location/designation and Elevation Certificate (if applicable) Location of all utilities, including electric, gas, water and sewer Location of meter, transformers and utility poles. Include amperage, voltage and phases Water and sewer mains shall be indicated and the location of all valves, meters, manholes and fire hydrants Retention/Detention Plan with stormwater report. (Meeting all requirements of stormwater ordinance approv 7-1-14) Retaining wall with heights Traffic Impact analysis and plan (if applicable) Off street parking spaces and driveways - # of spaces labeled (including handicapped) Indicate location of any requested Transit Stops/shelters, if applicable (All transit stops must be approv through OUT Transit) Location of all refuse containers or dumpsters Existing tree survey, tree mitigation calculations and landscape plan Plans for amentities/recreation facilities (if appl	Physical Address of Site			
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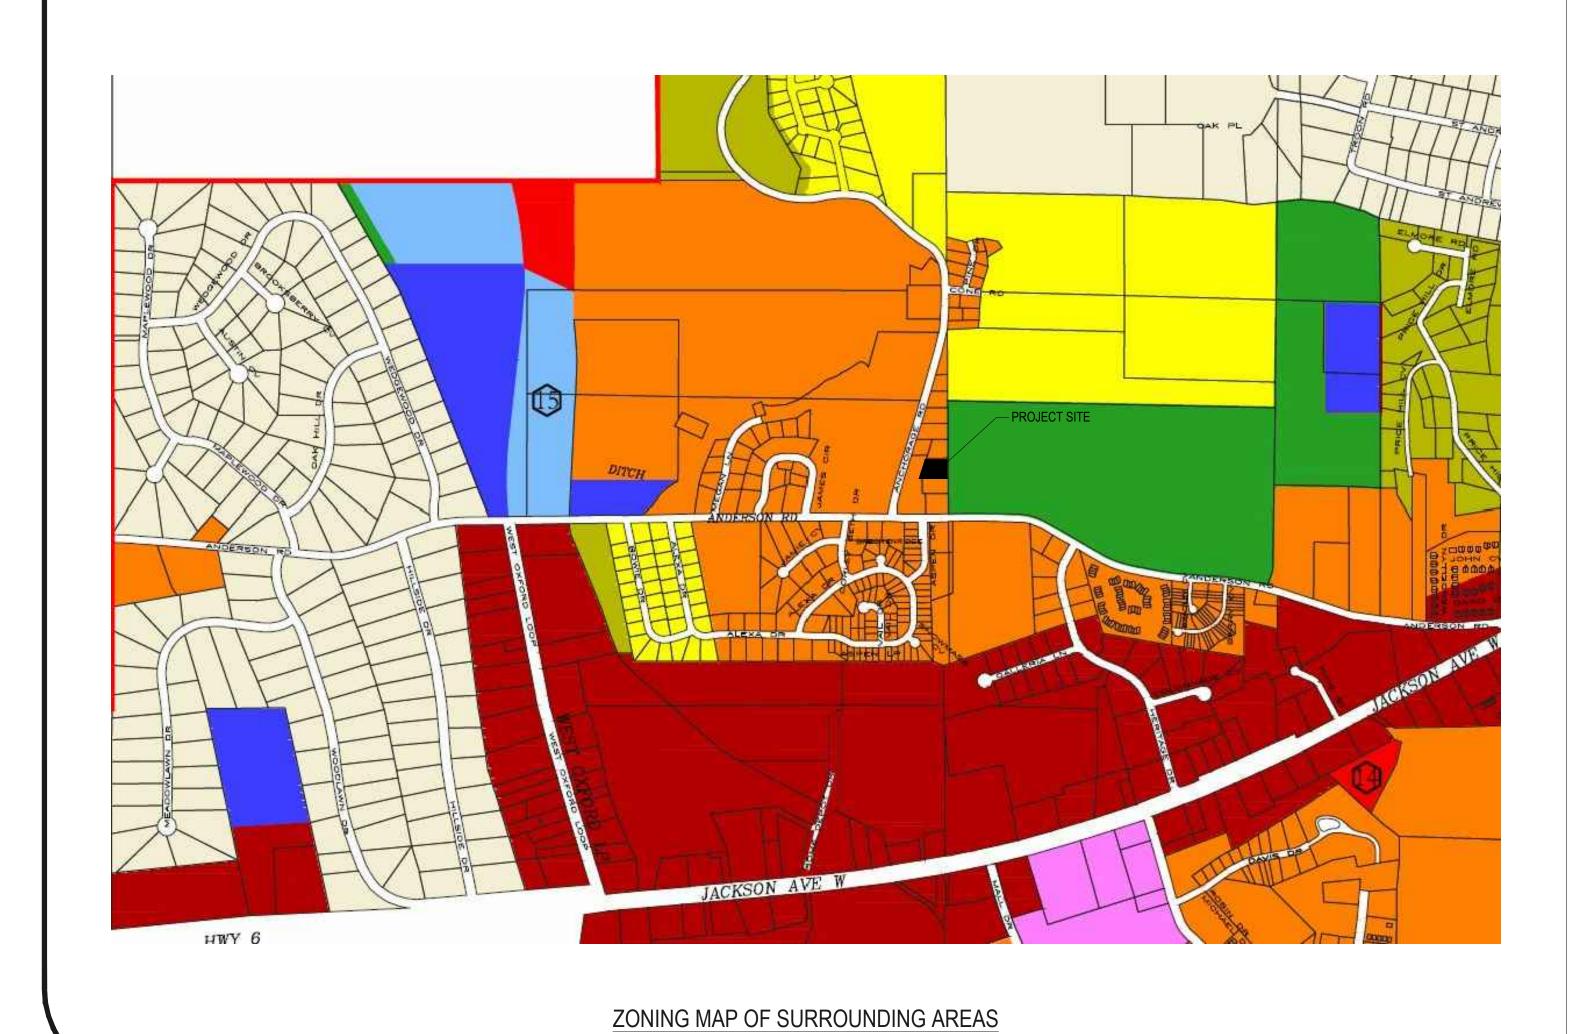
Please note: Applications submitted more than two times may incur additional application fees.

Signature of Owner or Authorized Agent	Į.	Date	<u> </u>

AERIAL PHOTO OF SURROUNDING AREAS

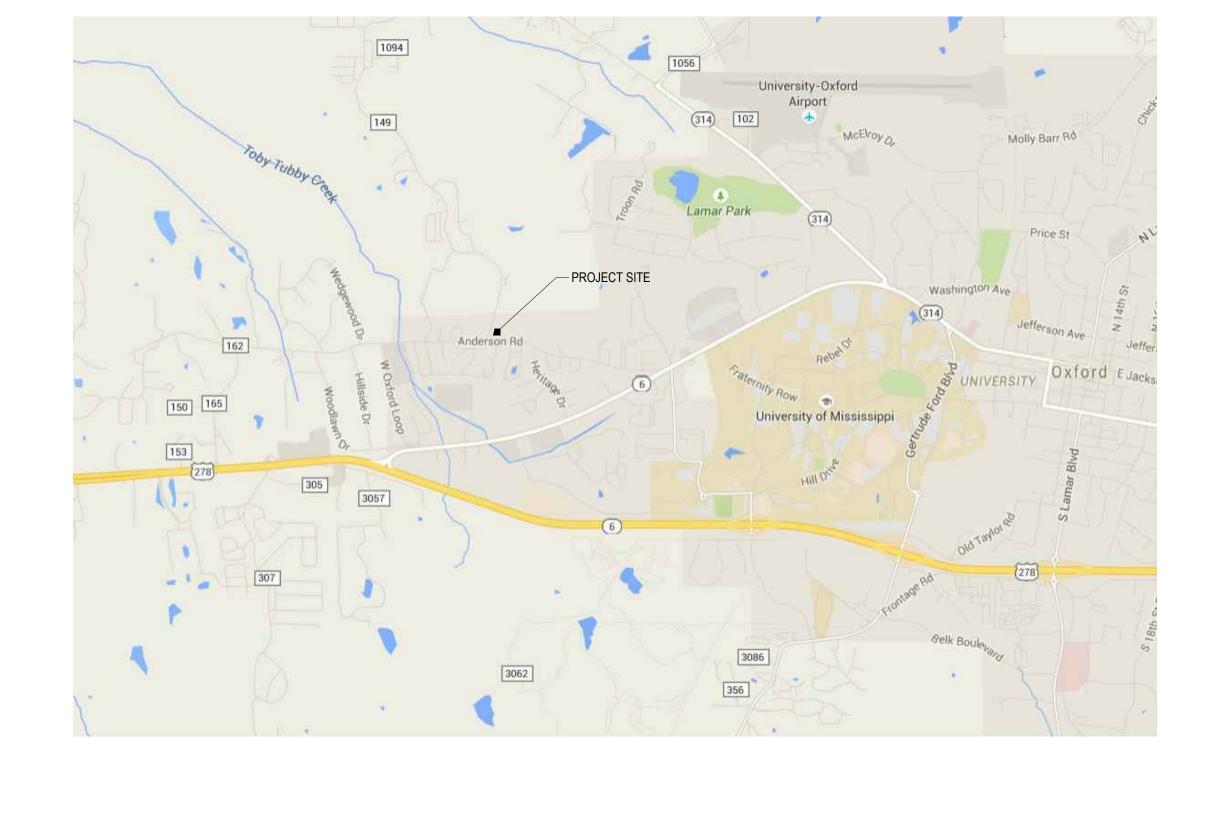

GENERAL MAP OF SURROUNDING AREAS



Site Design For:

RILEY COVE
Section 24, Township 8S, Range 4W

CONSULTANTS, INC. fessional Land Surveyors

WILLIAMS ENGINEERING
Professional Engineers | Profe

REVISION DATE

City Comments #1 6/25/15

City Comments #2 7/17/15

City Comments #3 7/28/15

File: \\Server01\projects\SV\SV-142578

Proj.No.: SV-142578

1" = 30'

Drawn By: JRM

Checked By: JWW


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Maps

Sheet No.:

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#### Bishop Harvey, Jr., Etal



General Notes

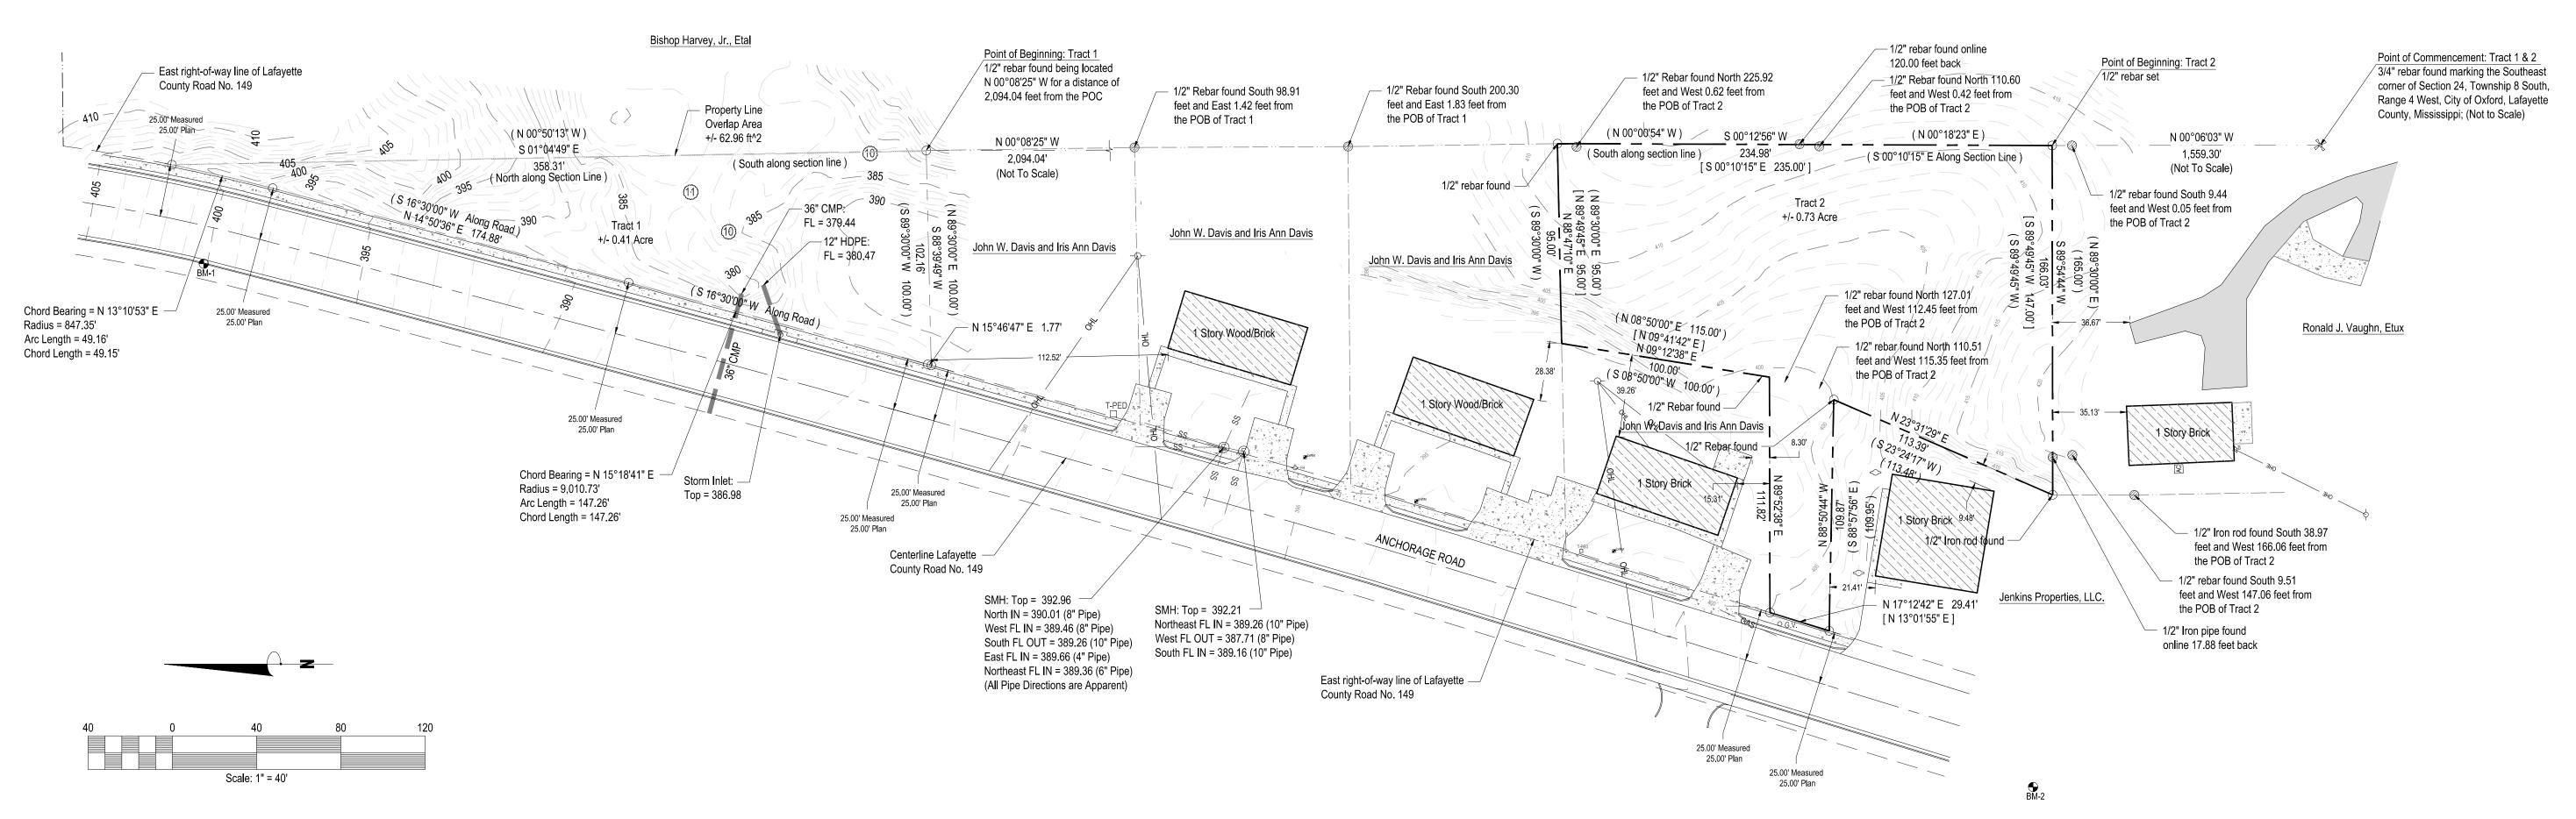1) IT IS RECOMMENDED THAT SOIL BORINGS BE PERFORMED ON SITE PRIOR TO CONSTRUCTION

2) IT SHALL BE THE RESPONSIBILITY OF THE CONTRACTOR TO PROTECT EXISTING STRUCTURES SUCH AS PIPES, INLETS, CURBS, ETC. FROM DAMAGE WHICH MIGHT OCCUR DURING CONSTRUCTION. EXTREME CARE SHALL BE EXERCISED IN UNDERCUT AREAS AND THE UNDERCUT DEPTH MAY BE ADJUSTED AT CROSS DRAINS, AS DIRECTED BY THE ENGINEER. THE CONTRACTOR SHALL REPLACE OR REPAIR, AS DIRECTED BY THE ENGINEER, ANY STRUCTURES DAMAGED DURING THE LIFE OF THE CONTRACT. NO PAYMENT WILL BE MADE FOR REPLACEMENT OR REPAIR OF DAMAGES.

3) ALL EXISTING UTILITIES OR OTHER OBSTRUCTIONS, WHICH CONFLICT WITH REQUIRED CONSTRUCTION SHALL BE REMOVED AT THE CONTRACTOR'S EXPENSE AS AN ABSORBED ITEM.

4) THE EROSION CONTROL DEVICES REFERENCED IN THESE PLANS ARE A MINIMUM REQUIREMENT. IT IS THE RESPONSIBILITY OF THE CONTRACTOR TO INSURE THAT SILT DOES NOT LEAVE THE CONSTRUCTION SITE OR CONTAMINATE WATERS OF THE U.S. DURING CONSTRUCTION. THE CONTRACTOR SHALL MAINTAIN A "SMALL CONSTRUCTION NOTICE OF INTENT" PERMIT AS REQUIRED BY THE MISSISSIPPI DEPARTMENT OF ENVIRONMENTAL QUALITY AND MAINTAIN THE PLAN DURING CONSTRUCTION.

5) EXISTING UTILITIES ON THE DRAWINGS ARE SHOWN IN THEIR ORIGINAL LOCATION BASED UPON THE BEST INFORMATION AVAILABLE TO THE ENGINEER. THE ENGINEER CAN NOT AND DOES NOT WARRANT THAT THIS INFORMATION IS COMPLETE OR ACCURATE. THE CONTRACTOR MUST COORDINATE DIRECTLY WITH THE INVOLVED UTILITY OWNERS (INCLUDING MISSISSIPPI ONE CALL) TO HAVE UNDERGROUND UTILITY LINES LOCATED IN ADVANCE OF CONSTRUCTION.

6) WORK ON STRUCTURES FOR THIS PROJECT REQUIRES EXCAVATION IN THE IMMEDIATE VICINITY OF ADJACENT PROPERTIES. THEREFORE, THE RISK OF A FAILURE OCCURRING DURING THE EXCAVATION REQUIRES THAT EXTREME CAUTION BE EXERCISED. IT SHALL BE THE CONTRACTOR'S RESPONSIBILITY TO PLACE WHAT BRACING, SHORING OR GROUND SUPPORT SYSTEM THAT IS DEEMED NECESSARY TO PREVENT A FAILURE AND PROTECT THE PERSONS WORKING NEAR THE EXCAVATION, THE PUBLIC THAT MAY BE ABOVE THE EXCAVATION OR ANY STRUCTURE ADJACENT TO THE EXCAVATION. ALL COSTS FOR ANY PROTECTIVE MEASURES, INCLUDING THE MATERIALS AND LABOR FOR DESIGNING, DRAWING AND CONSTRUCTING THE FACILITY, SHALL BE INCLUDED IN THE PRICE BID FOR CONTRACT ITEMS.

7) IN ORDER TO HOLD SILT TO A MINIMUM, IT SHALL BE THE RESPONSIBILITY OF THE CONTRACTOR TO INSTALL AND MAINTAIN TEMPORARY EROSION CONTROL MEASURES (SILT FENCE, DITCH CHECKS, ETC.)

8) ANY AREAS DISTURBED DURING CONSTRUCTION SHALL BE RESTORED BY THE CONTRACTOR (TO INCLUDE GRASSING AND SITE GRADING) AS DIRECTED BY THE ENGINEER, ARCHITECT OR OWNER. CONTRACTOR SHALL PROVIDE TEMPORARY EROSION CONTROL FOR DISTURBED AREA UNTIL THEY HAVE BEEN GRASSED AND GROWTH ESTABLISHED.

9) THIS PLAN DOES NOT RELIEVE THE CONTRACTOR OF THE RESPONSIBILITY OF INSTALLING TRAFFIC CONTROL DEVICES IN ACCORDANCE WITH THE MUTCD. OTHER SIGNS AND TRAFFIC CONTROL DEVICES MAY BE REQUIRED DURING THE VARIOUS PHASES OF CONSTRUCTION. ALL TRAFFIC CONTROL DEVICES ON THIS PROJECT SHALL COMPLY WITH PART VI OF THE M.U.T.C.D. (LATEST EDITION).

10) THE CONTRACTOR IS TO REMOVE AND RESET ANY SIGNS WHICH CONFLICT WITH CONSTRUCTION.

11) THE CONTRACTOR IS RESPONSIBLE FOR FIELD VERIFICATION OF EXISTING GRADES AND MAKING ADJUSTMENTS AS NECESSARY WITH THE APPROVAL OF THE PROJECT ENGINEER.

12) TRUNCATED DOMES REQUIRED AT ALL SIDEWALK CROSSINGS, COLOR SHALL MEET SPECIFICATIONS FOR THE CITY OF OXFORD.

13) ALL SPOT GRADES SHOWN ALONG CURB ARE TO TOP BACK OF CURB, GRADES SHOWN IN OTHER AREAS ARE TO FINISHED GRADE.

14) CONTRACTOR SHALL ENSURE POSITIVE DRAINAGE AWAY FROM BUILDING.

15) CONTRACTOR SHALL VERIFY ALL SIDEWALKS AND RAMPS MEET A.D.A. REQUIREMENTS.

16) BOUNDARY AND TOPOGRAPHIC SURVEY PROVIDED BY WILLIAMS ENGINEERING CONSULTANTS, INC.

Mississippi 811 ( E-Locate ) Date Submitted: November 20, 2014 Verification # 14112016260927

TELEPAK DBA C SPIRE FIBER NORTHEAST MS EPA
METROCAST OF MS CENTERPOINT ENERGY OXFORD
CITY OF OXFORD AT&T DISTRIBUTION TUPELO

Site Design For:

LEY COVE

Township 8S, Range 4W

Lafavette County, Mississippi

CONSULTANTS, INC

ENGINEERING (

WILLIAMS | Professiona

 REVISION
 DATE

 City Comments #1
 6/25/15

 City Comments #2
 7/17/15

 City Comments #3
 7/28/15

Scale: 1" = 40'

Date: 01/27/2015

File: \\Server01\projects\\SV\\SV-142578

Proj.No.: SV-142578

Drawn By: JRM


Checked By: JWW

Sheet Title:

Existing Site Conditions

Sheet No.:

C 1.0

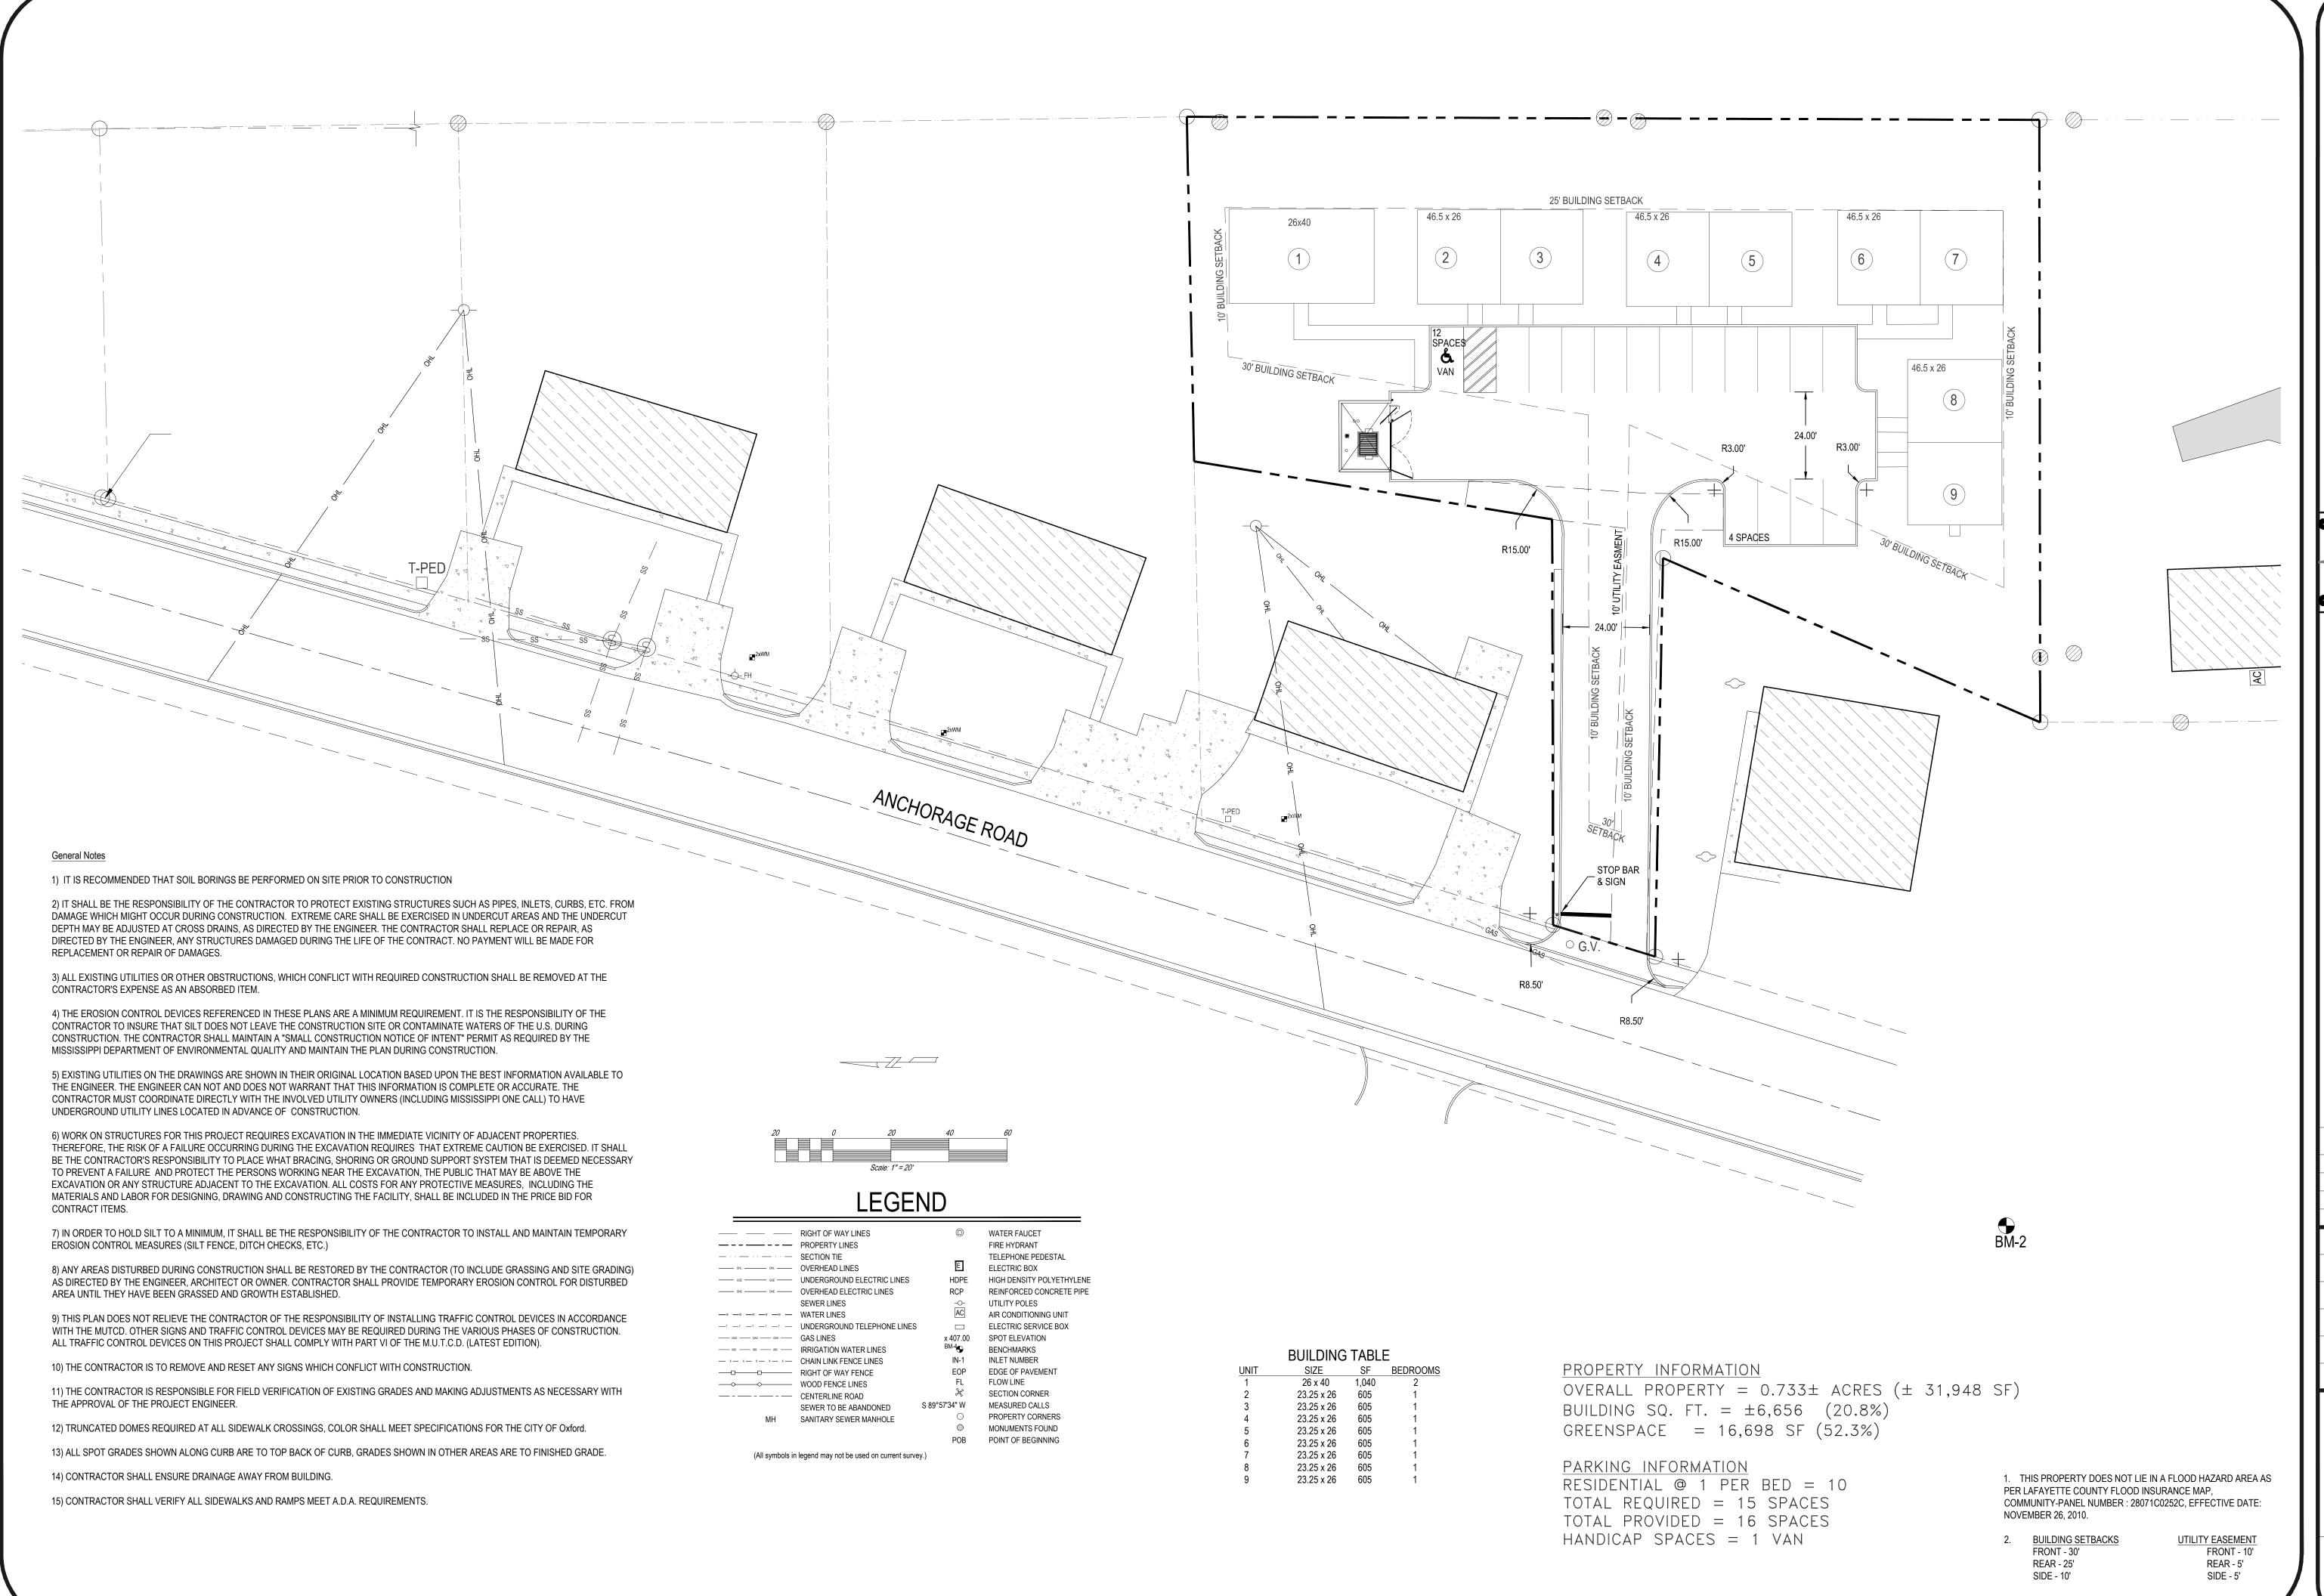

CONSULTANTS, INC ssional Land Surveyors WILLIAMS ENGINEERING
Professional Engineers Profe REVISION City Comments #3 7/28/15

DATE City Comments #1 6/25/15 City Comments #2 7/17/15

1" = 20' Scale: 01/27/2015 File: \\Server01\projects\\SV\SV-142578 SV-142578 JRM


Drawn By: Checked By: JWW

Sheet Title:

Layout

Sheet No.:

C 2.0

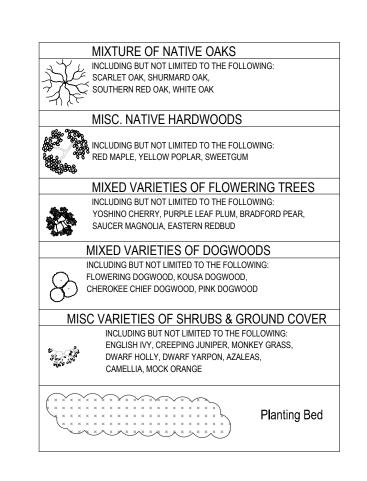

SITE/LANDSCAPING

SITE LANDSCAPE NOTES

# TOPSOIL & MULCH

IT IS THE RESPONSIBILITY OF THE GENERAL CONTRACTOR TO FILL PLANTING BEDS WITH 4" OF THE BEST AVAILABLE ON-SITE TOPSOIL. IF THE LANDSCAPE CONTRACTOR FEELS THAT MORE ON-SITE TOPSOIL OR OFF-SITE TOPSOIL IS REQUIRED FOR THE LONG TERM SURVIVAL OF THE PLANT MATERIALS, THEN HE SHALL INCLUDE THIS ON HIS PROPOSAL AS AN ALTERNATE.

TOPSOIL SHALL BE CLEANED AND PULVERIZED AS NECESSARY BY LANDSCAPE CONTRACTOR TO PROVIDE A FINE, EVEN TEXTURED SOIL FOR PLANTING BEDS.

LANDSCAPE CONTRACTOR SHALL PROVIDE FERTILIZER FOR PLANTING BEDS AS REQUIRED.

LANDSCAPE CONTRACTOR SHALL PROVIDE 2" OF BARK MULCH AT ALL PLANTING BEDS, INDIVIDUAL TREES AND SHRUB GROUPINGS. PRIOR TO MULCHING,

# PLANTING BEDS SHALL BE TREATED WITH A GRANULAR HERBICIDE TO PREVENT WEED GROWTH.

INDIVIDUAL TREES SHALL HAVE 3' DIAMETER MIN OF MULCH. SHRUB GROUPINGS SHALL HAVE CONTINUOUS MULCH AREA OF 3' MIN WIDTH. ENTIRE AREA OF PLANTING BEDS SHALL BE MULCHED, UNLESS OTHERWISE NOTED.


# PLANT MATERIAL

PROVIDE & INSTALL PLANT MATERIAL AS PER MATERIAL SCHEDULE.

# LANDSCAPE CONTRACTOR SHALL PROVIDE FOR THE FOLLOWING:

1. WATERING OF ALL PLANT MATERIALS FOR 30 DAYS AFTER COMPLETION OF INSTALLATION. WATERING MAY BE BY IRRIGATION SYSTEM, IF ANY; SITE OR BUILDING WATER LINES; OR IF NECESSARY, BY WATER HAULED ONTO SITE. COORDINATE WITH THE OWNER REGARDING WATERING METHOD.

- 2. GENERAL CARE INCLUDING, BUT NOT LIMITED TO, FERTILIZATION, REQUIRED HERBICIDAL OR PESTICIDAL TREATMENTS, PRUNING & WEEDING, FOR 30 DAYS AFTER COMPLETION OF INSTALLATION. THIS SHALL NOT INCLUDE MOWING GRASS OUTSIDE PLANTING BEDS.
- 3. CONTRACTOR SHALL COORDINATE WITH THE OWNERS PROPERTY MANAGER FOR LONG TERM MAINTENANCE OF THE PLANTINGS.
- 4. LANDSCAPE DESIGNER, LANDSCAPE INSTALLER AND OWNER SHALL ADJUST PLANT MATERIAL TO BETTER BLEND INTO THE NEIGHBORHOOD AND ENVIRONMENT. ALL REPLACEMENT PLANT MATERIALS SHALL MEET OR EXCEED THE CITY OF OXFORD REQUIREMENTS.

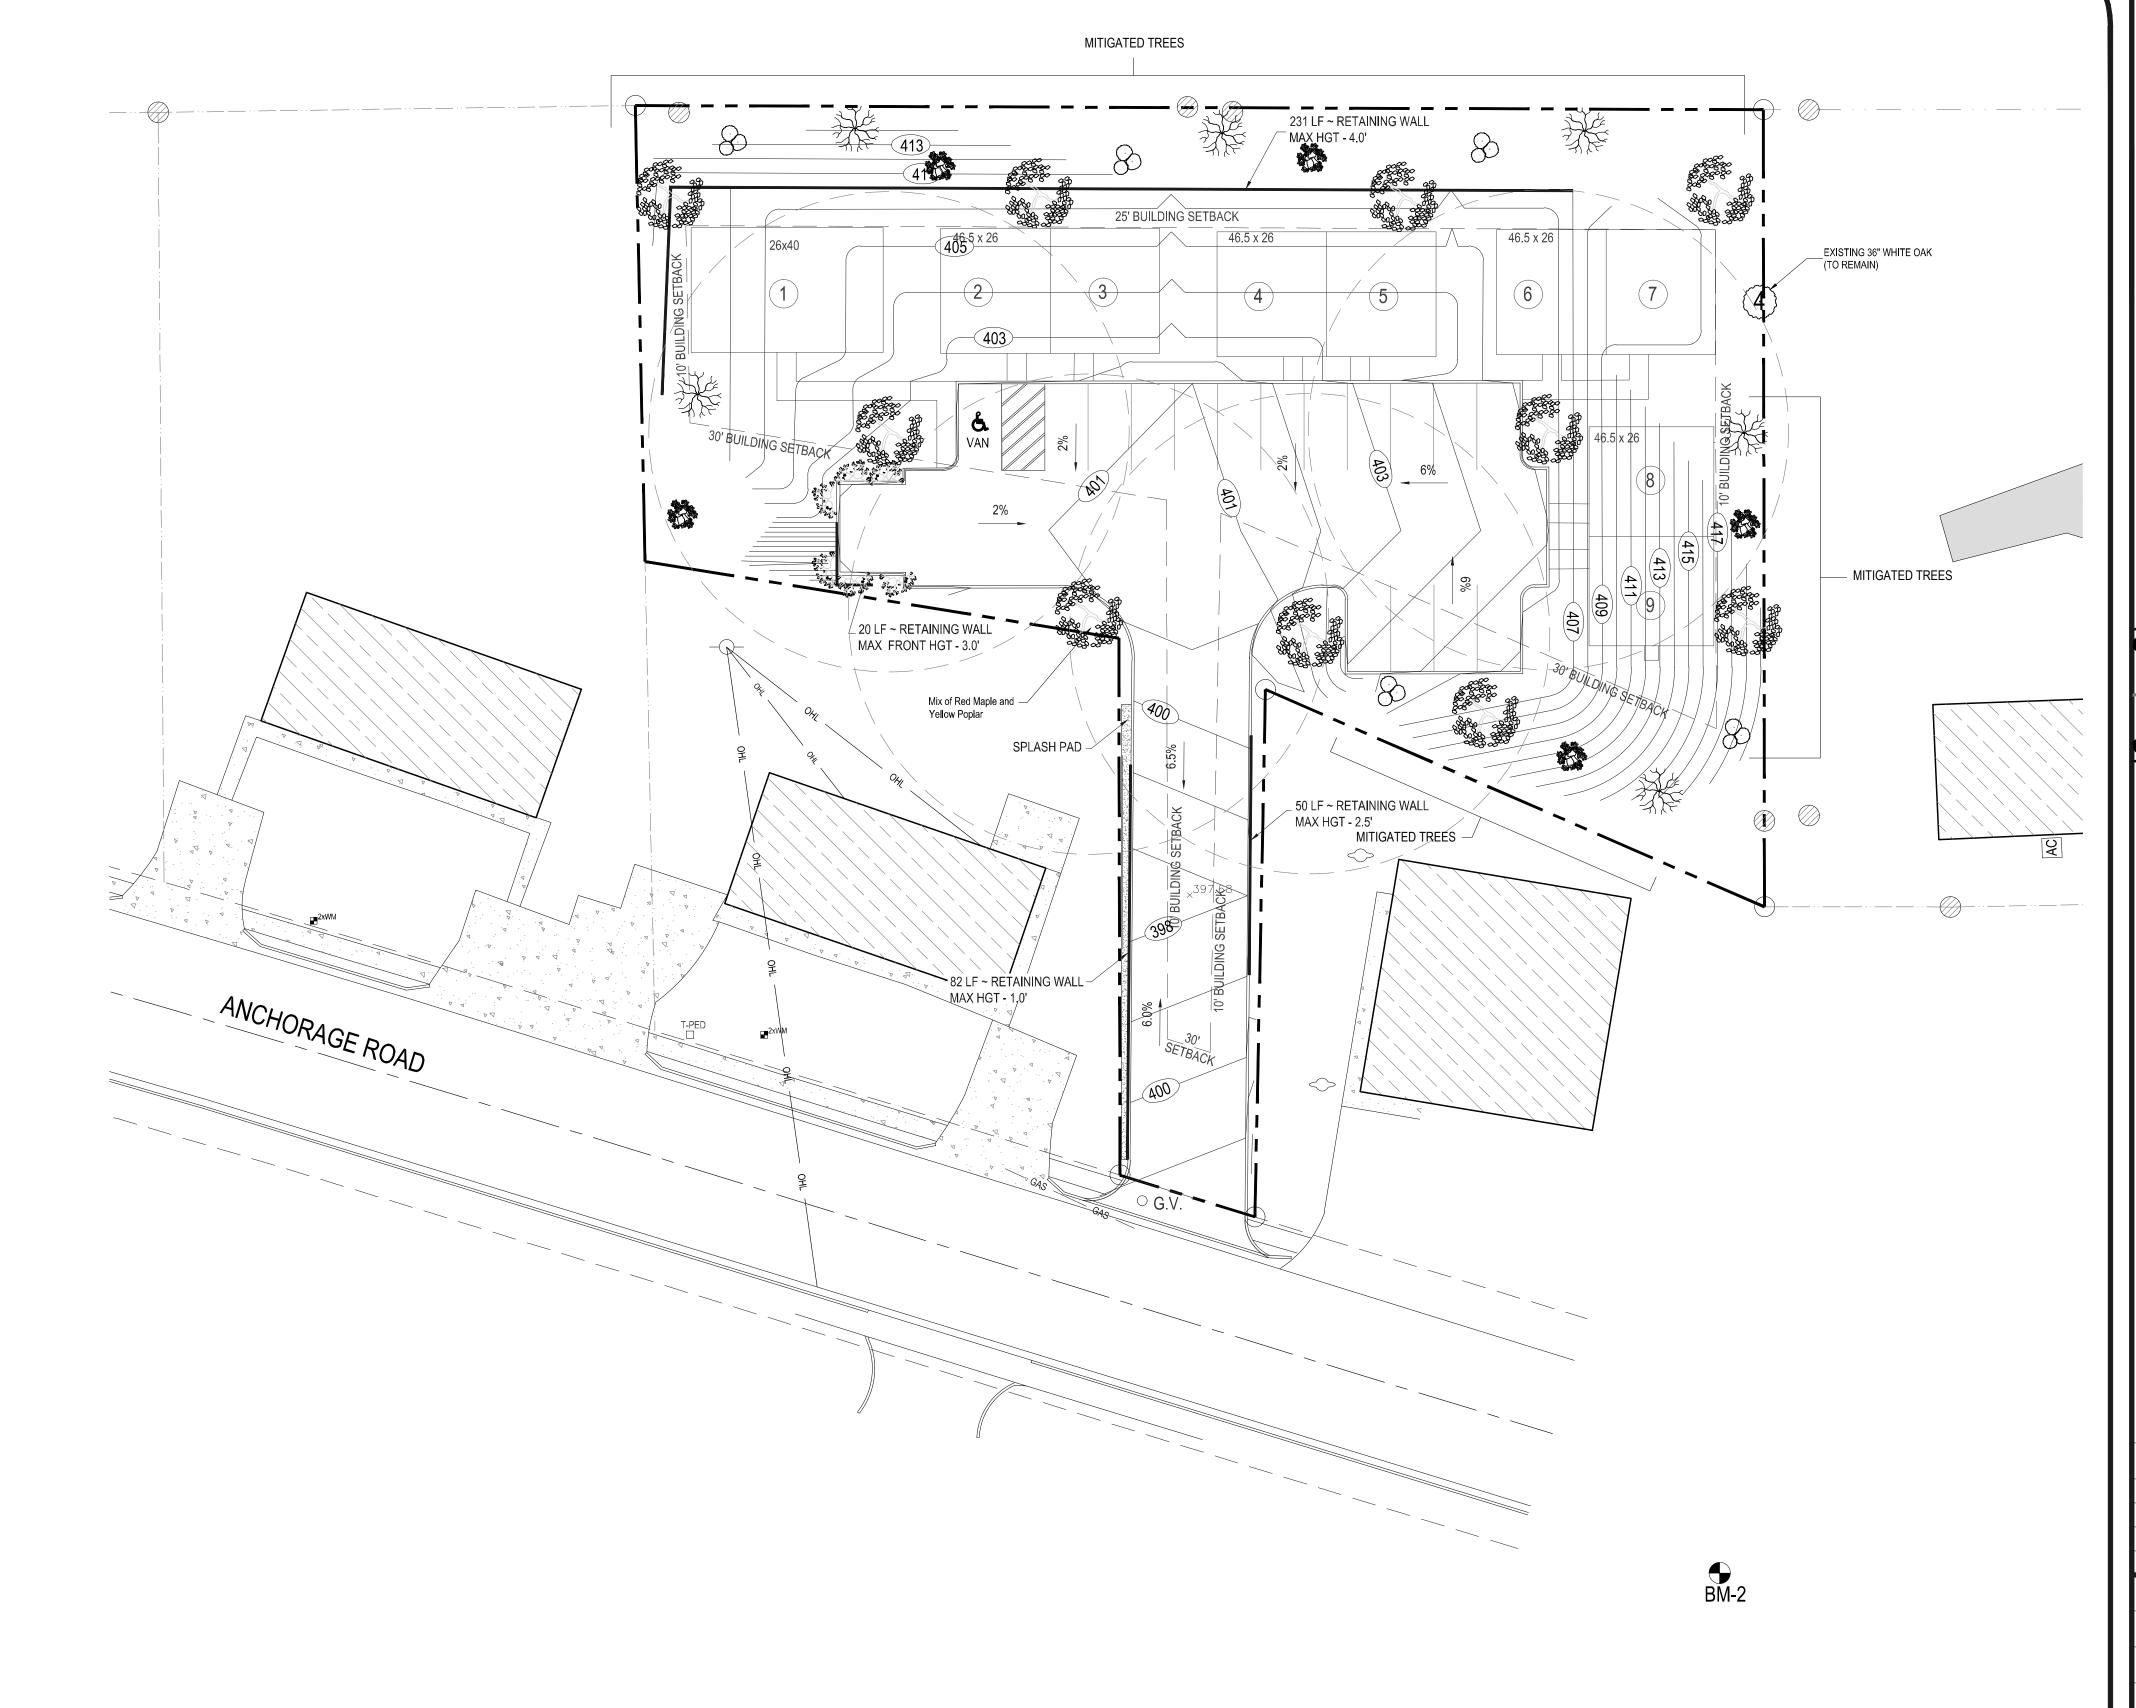

WILLIAMS ENGINEERING CONSULTANTS, INC. Professional Engineers Professional Land Surveyors

Site Design For:

RILEY COVE
Section 24, Township 8S, Range 4W
Sity of Oxford, Lafayette County, Mississipp

City Comments #1 6/25/15

City Comments #2 7/17/15

City Comments #3 7/28/15

Scale: 1" = 20'

Date: 01/27/2015

File: \\Server01\projects\SV\SV-142578

Proj.No.: SV-142578

Drawn By: JRM

Checked By: JWW

Sheet Title:

REVISION

Landscape Plan

Sheet No.:

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WILLIAMS ENGINEERING CONSULTANTS, INC. Professional Engineers Professional Land Surveyors

REVISION DATE City Comments #1 6/25/15 City Comments #2 7/17/15 City Comments #3 7/28/15

Scale: NTS File: \\Server01\projects\SV\SV-142578

SV-142578 Proj.No.:


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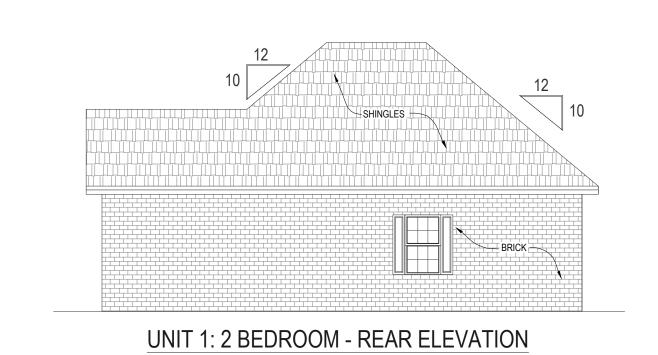
Sheet Title:

Architectural

Sheet No.:

C 9.0




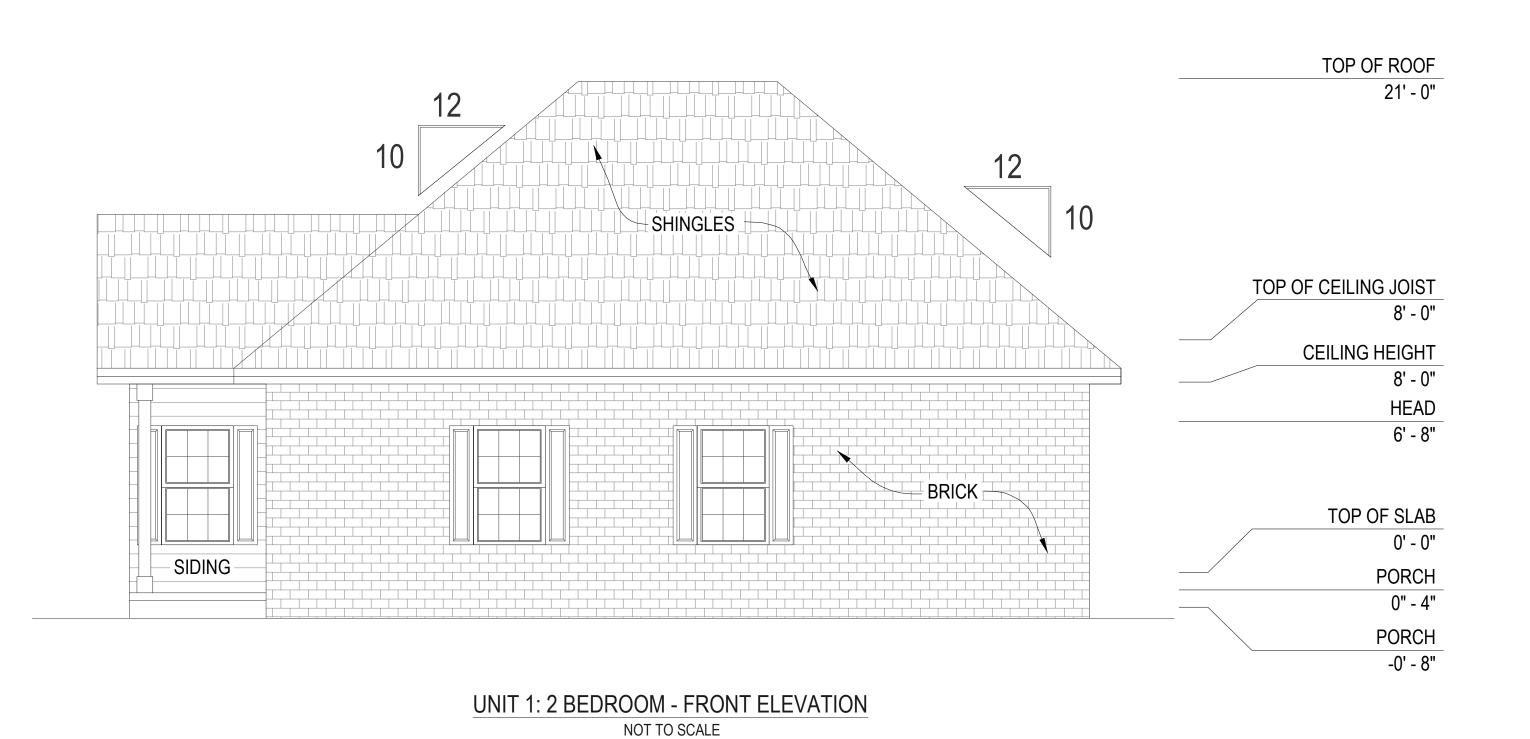


NOT TO SCALE


UNIT 1: 2 BEDROOM - RIGHT ELEVATION NOT TO SCALE

UNIT 1: 2 BEDROOM - LEFT ELEVATION NOT TO SCALE

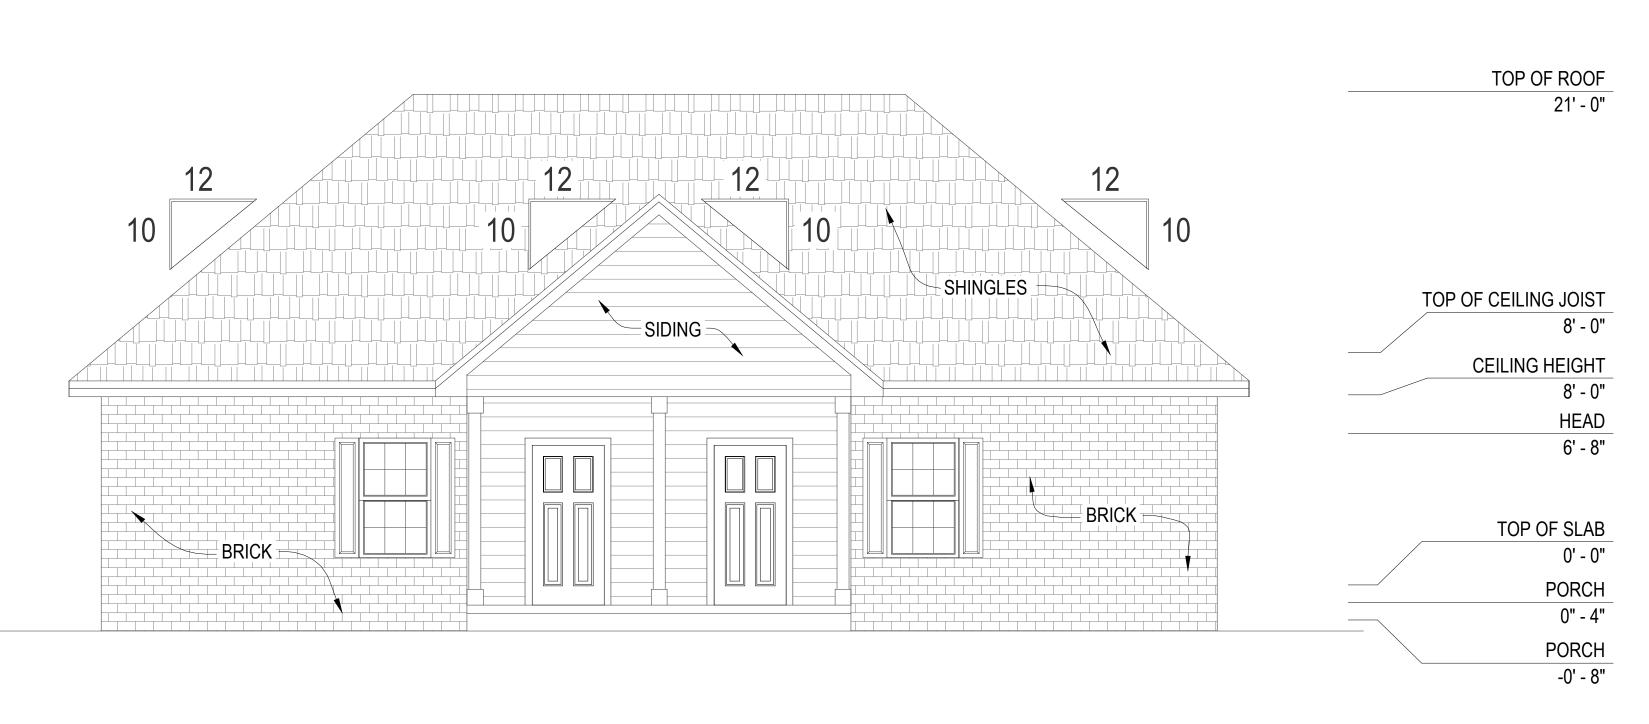

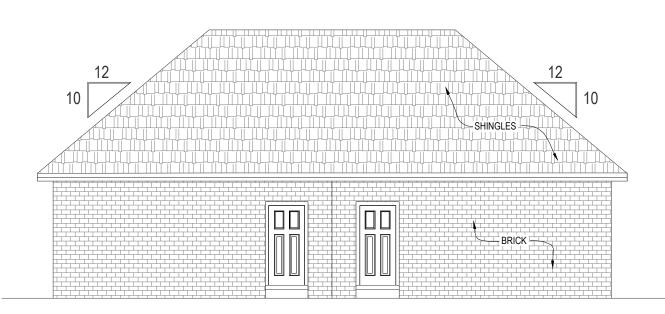

DUPLEX UNITS 2 - 7: 1 BEDROOM - REAR ELEVATION NOT TO SCALE

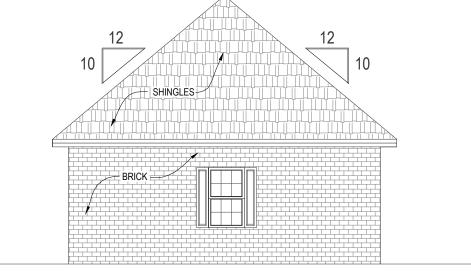

DUPLEX UNITS 2 - 7: 1 BEDROOM - RIGHT ELEVATION NOT TO SCALE


DUPLEX UNITS 2 - 7: 1 BEDROOM - LEFT ELEVATION

NOT TO SCALE


DUPLEX UNITS 2 - 7: 1 BEDROOM - FRONT ELEVATION NOT TO SCALE

\*ELEVATIONS PROVIDED BY OWNER. WILLIAMS ENGINEERING CONSULTANTS, INC IS NOT RESPONSIBLE BUILDING DESIGN OR CONSTRUCTION.

DUPLEX UNITS 8 - 9: 1 BEDROOM - FRONT ELEVATION
NOT TO SCALE

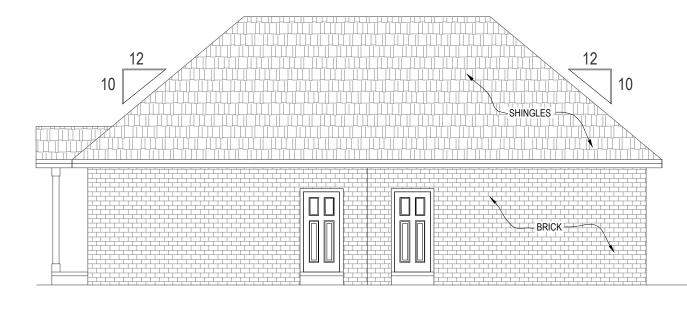


DUPLEX UNITS 8 - 9: 1 BEDROOM - REAR ELEVATION NOT TO SCALE

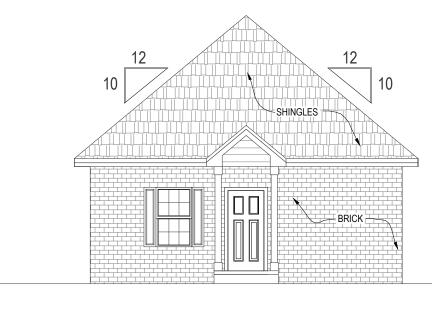

-0' - 8"

DUPLEX UNITS 8 - 9: 1 BEDROOM - RIGHT ELEVATION NOT TO SCALE

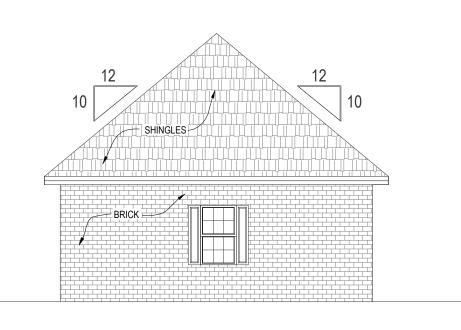

DUPLEX UNITS 8 - 9: 1 BEDROOM - LEFT ELEVATION NOT TO SCALE

Site Desig **RILEY C**Section 24, Townshi City of Oxford, Lafayette

WILLIAMS ENGINEERING CONSULTANTS, INC. Professional Engineers Professional Land Surveyors

REVISION	DATE
City Comments #1	6/25/15
City Comments #2	7/17/15
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Sheet Title:

Architectural Plans

Sheet No.:

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